

I. FOR SITE PLAN SEE:

GENERAL NOTES

"NEW SINGLE FAMILY RESIDENCE FOR ADAM & MAGGIE GOLDENSTEIN"

2. THESE PLANS ARE FOR THE BUILT OUT GUEST HOUSE AND WORKSHOP FINISHING INSIDE A VERSATUBE BRAND PRE-FAB METAL BUILDING. FOR THE PRE-FAB METAL BUILDING PLANS SEE: "34 X 54'2" X 16' SUMMIT, 12' ROOF ONLY LEAN-TO"

9 3/8"

MINI SPLIT HEAT PUMP

1/4" = 1'-0"

- 3. IN CASE OF ANY CONTRADICTION OF THESE PLANS AND AN ENGINEERED PORTION OF THE THE PRE-FAB METAL BUILDING PLANS, THE ENGINEERED PLANS SHALL APPLY.
- 4. SEE ADDITIONAL NOTES ON PAGE MI.01
- 5. SEE MECHANICAL PLAN FOR HEATING AND COOLING DETAILS.

13'-0"

26'-l 3/l6"

WORKSHOP

A2.01

13'-9 1/2"

4'-6"

1/4" = 1'-0"

IST FLOOR PLAN

18'-7 9/16"

BEDROOM

LIVING POOM

NET FLOOR AREA 153 S.F.

7'-5 5/8"

2ND FLOOR PLAN

CEILING HEIGHT: 7'-II" TO 9'4"

CEILING HEIGHT: 6'-4" TO 9'-4"

- 9'-10 3/4"

NET FLOOR AREA 158 S.F.

NOTE:

SECOND FLOOR BEDROOM WILL BE LIVED IN DURING CONSTRUCTION OF MAIN HOUSE. DUE TO SEPTIC SYSTEM SIZE LIMITATIONS THE DIVIDING WALL FOR THE SECOND FLOOR BEDROOM SHALL BE REMOVED BEFORE CERTIFICATE OF OCCUPANCY OF THE MAIN HOUSE LEAVING THE SHOP WITH ONLY ONE BEDROOM.


WINDOWS:

UNLESS OTHERWISE NOTED ALL WINDOWS ARE 4'X4' VINYL GLIDER OPENING WITH A U-FACTOR OF 0.35 AND SHGC OF 0.41. WINDOWS IN BEDROOMS SHALL MEET IRC2012 EGRESS REQUIREMENTS.

DOORS:

UNLESS OTHERWISE NOTED ALL DOORS ARE 3'x6'x8". DOORS OPENING INTO THE WORKSHOP SHALL MEET ALL REQUIREMENTS OF IRC2012 APPLICABLE TO GARAGE/DWELLING DOORS.

> NOTE TO BUILDING OFFICIAL: Please indicate if this detail is required or if the reinforced 6" slab per the pre-fab building plans is sufficient?

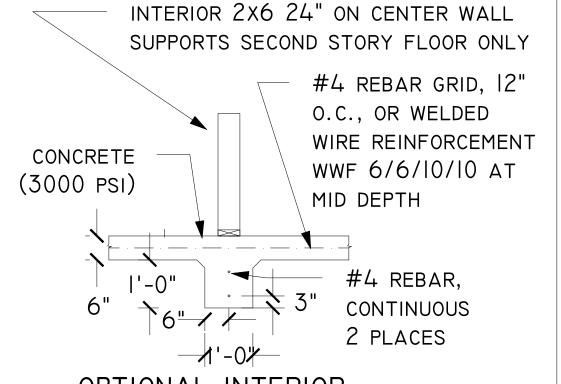

OPTIONAL INTERIOR BEARING WALL FOOTING

1/2" = 1'-0"


General Notes Rev 1: Changes to page E1.01 only. Added sub panel and misc electrical changes 3/15/19 REVISION | 5/18/18 INITIAL RELEASE Revision/Issue Date


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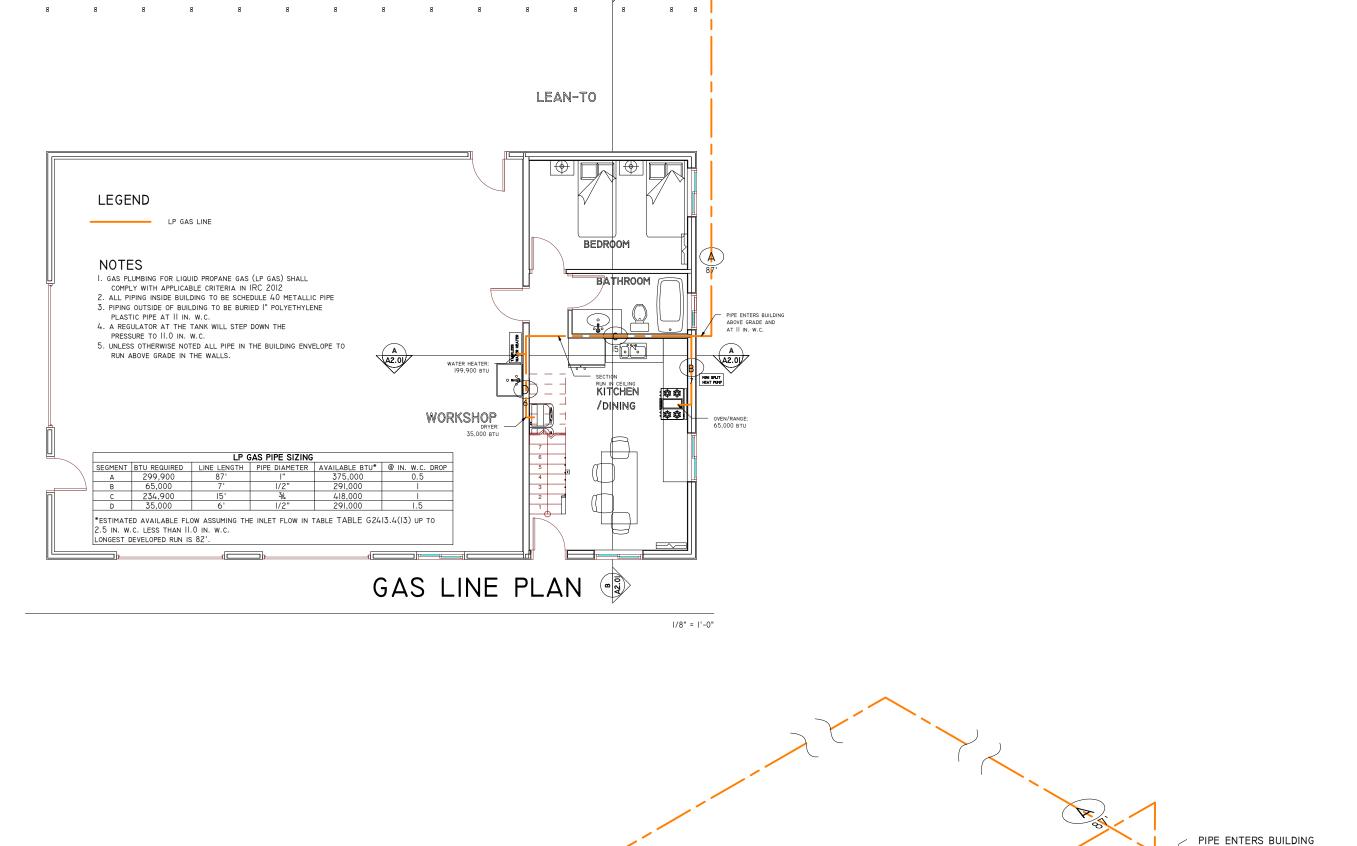
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ADAM GOLDENSTEIN AI.0I3/19/2019 | | / 4" = | ' - 0"

 \triangleleft





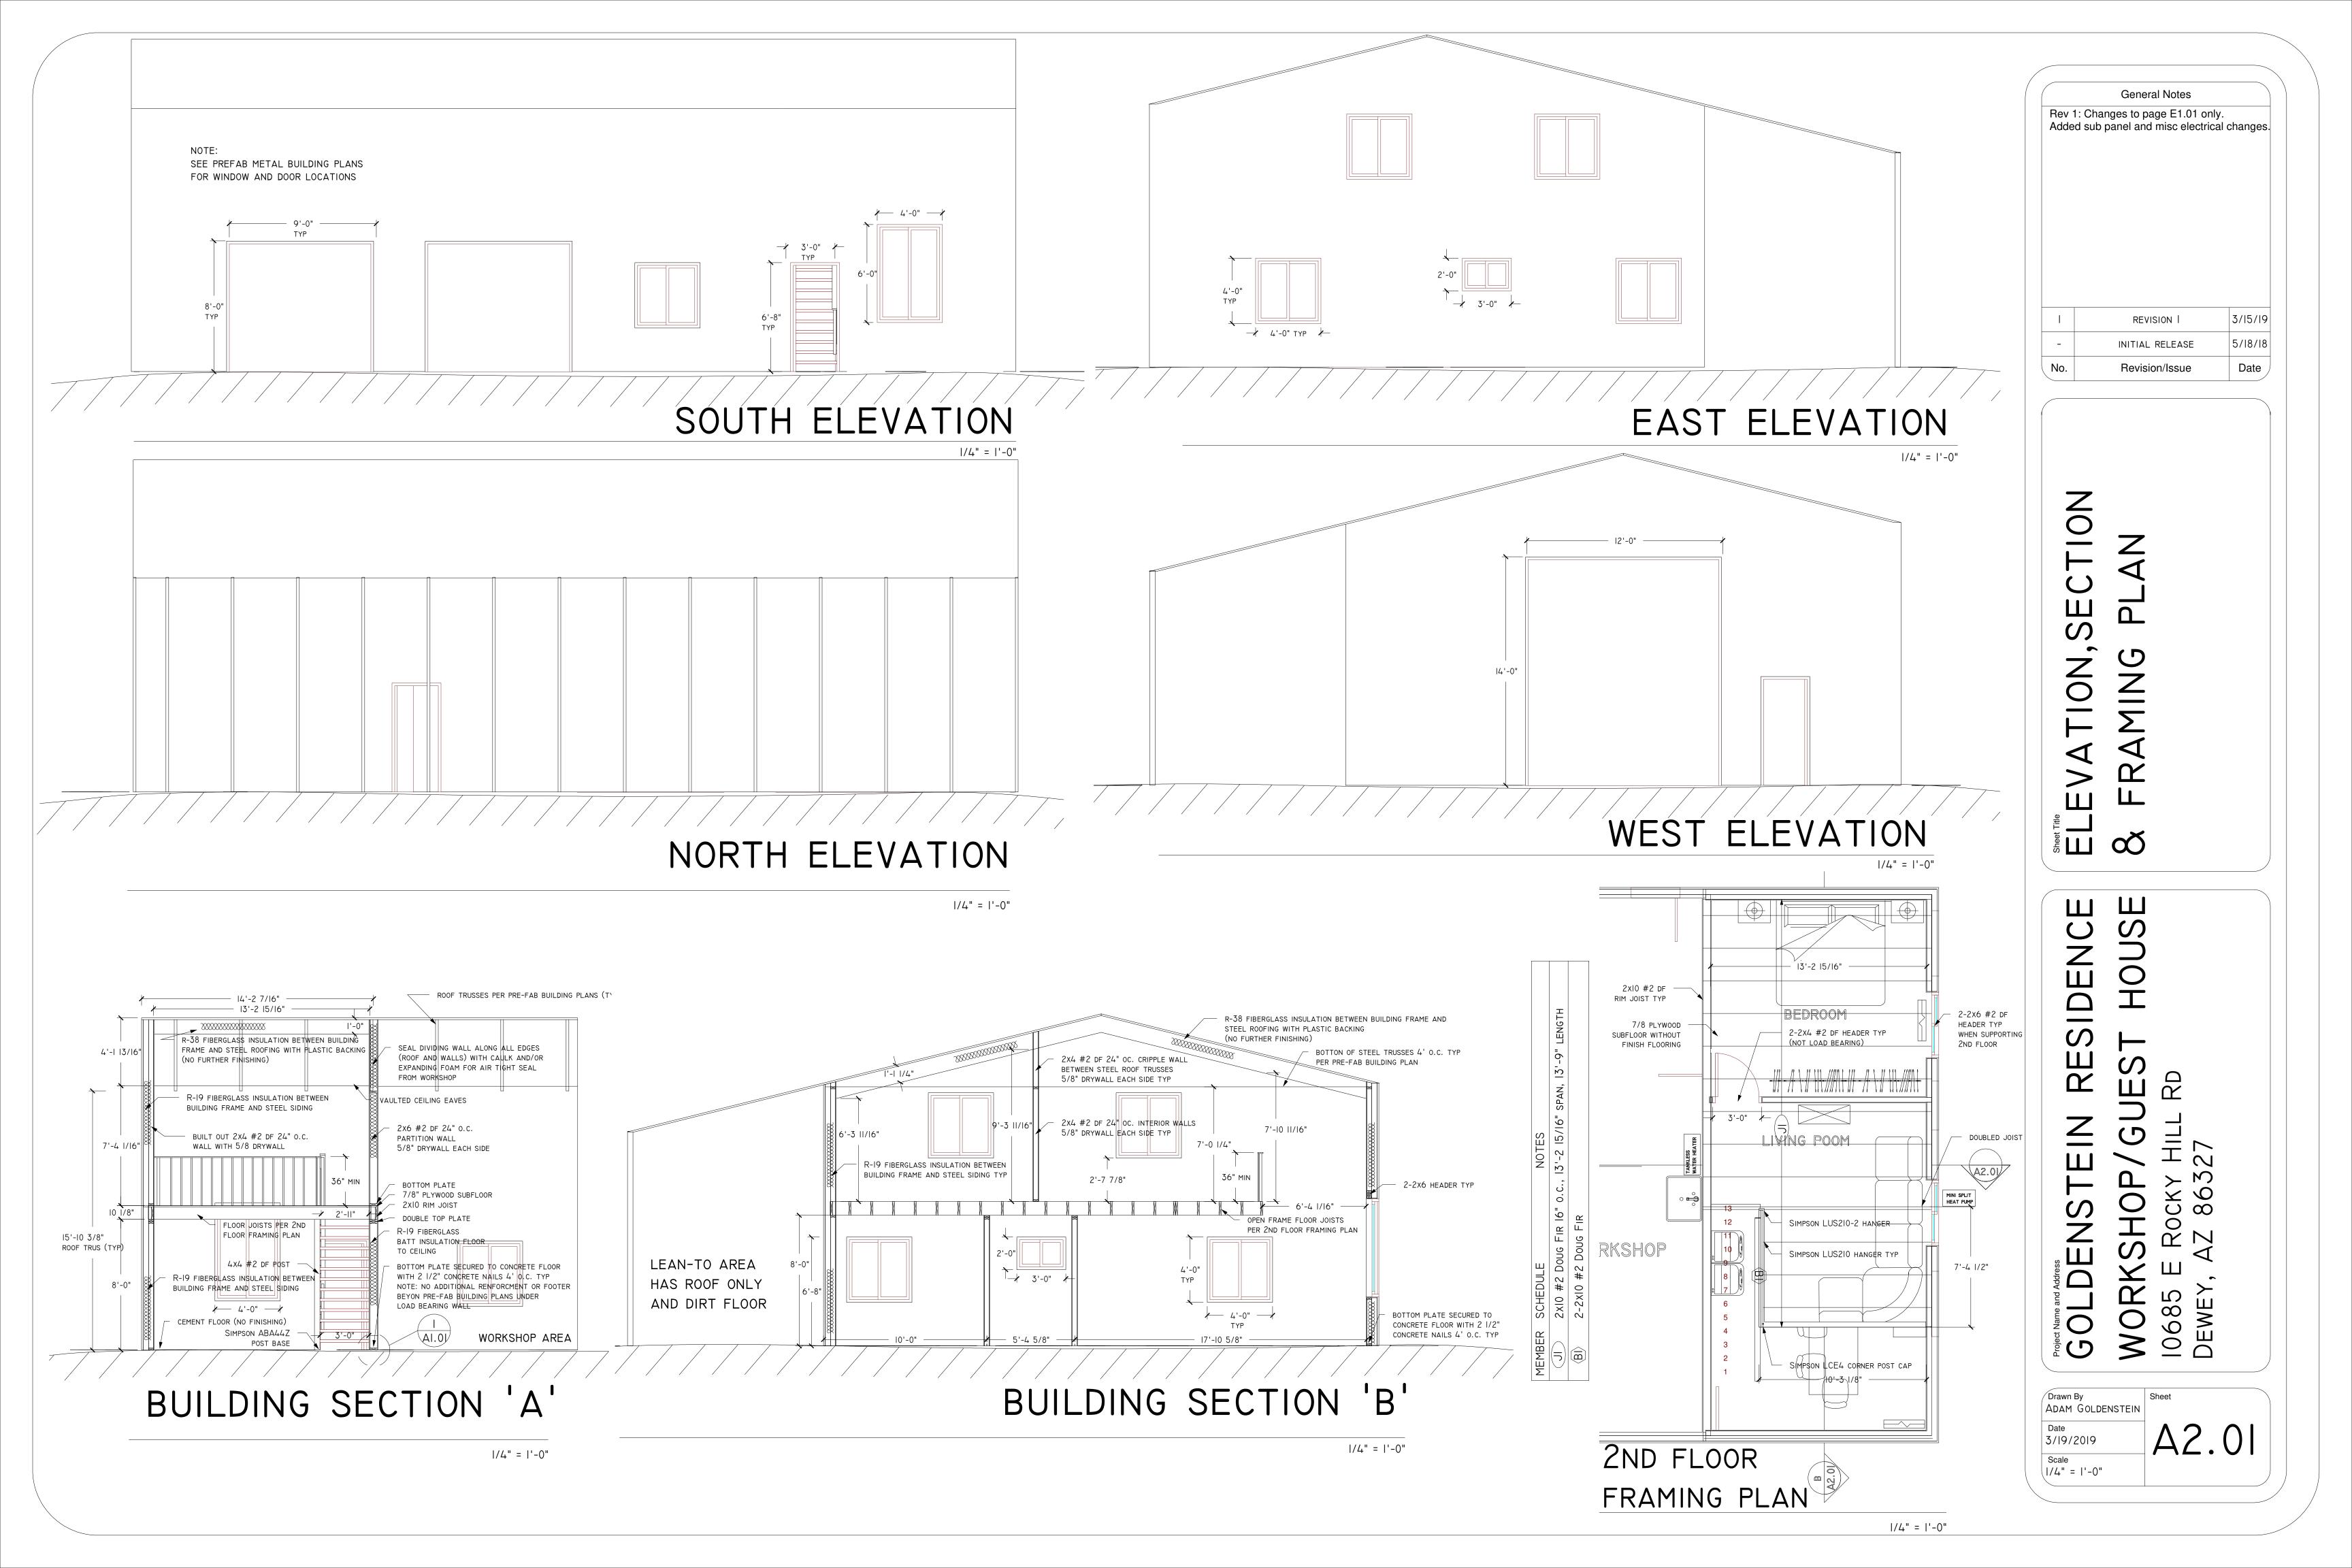

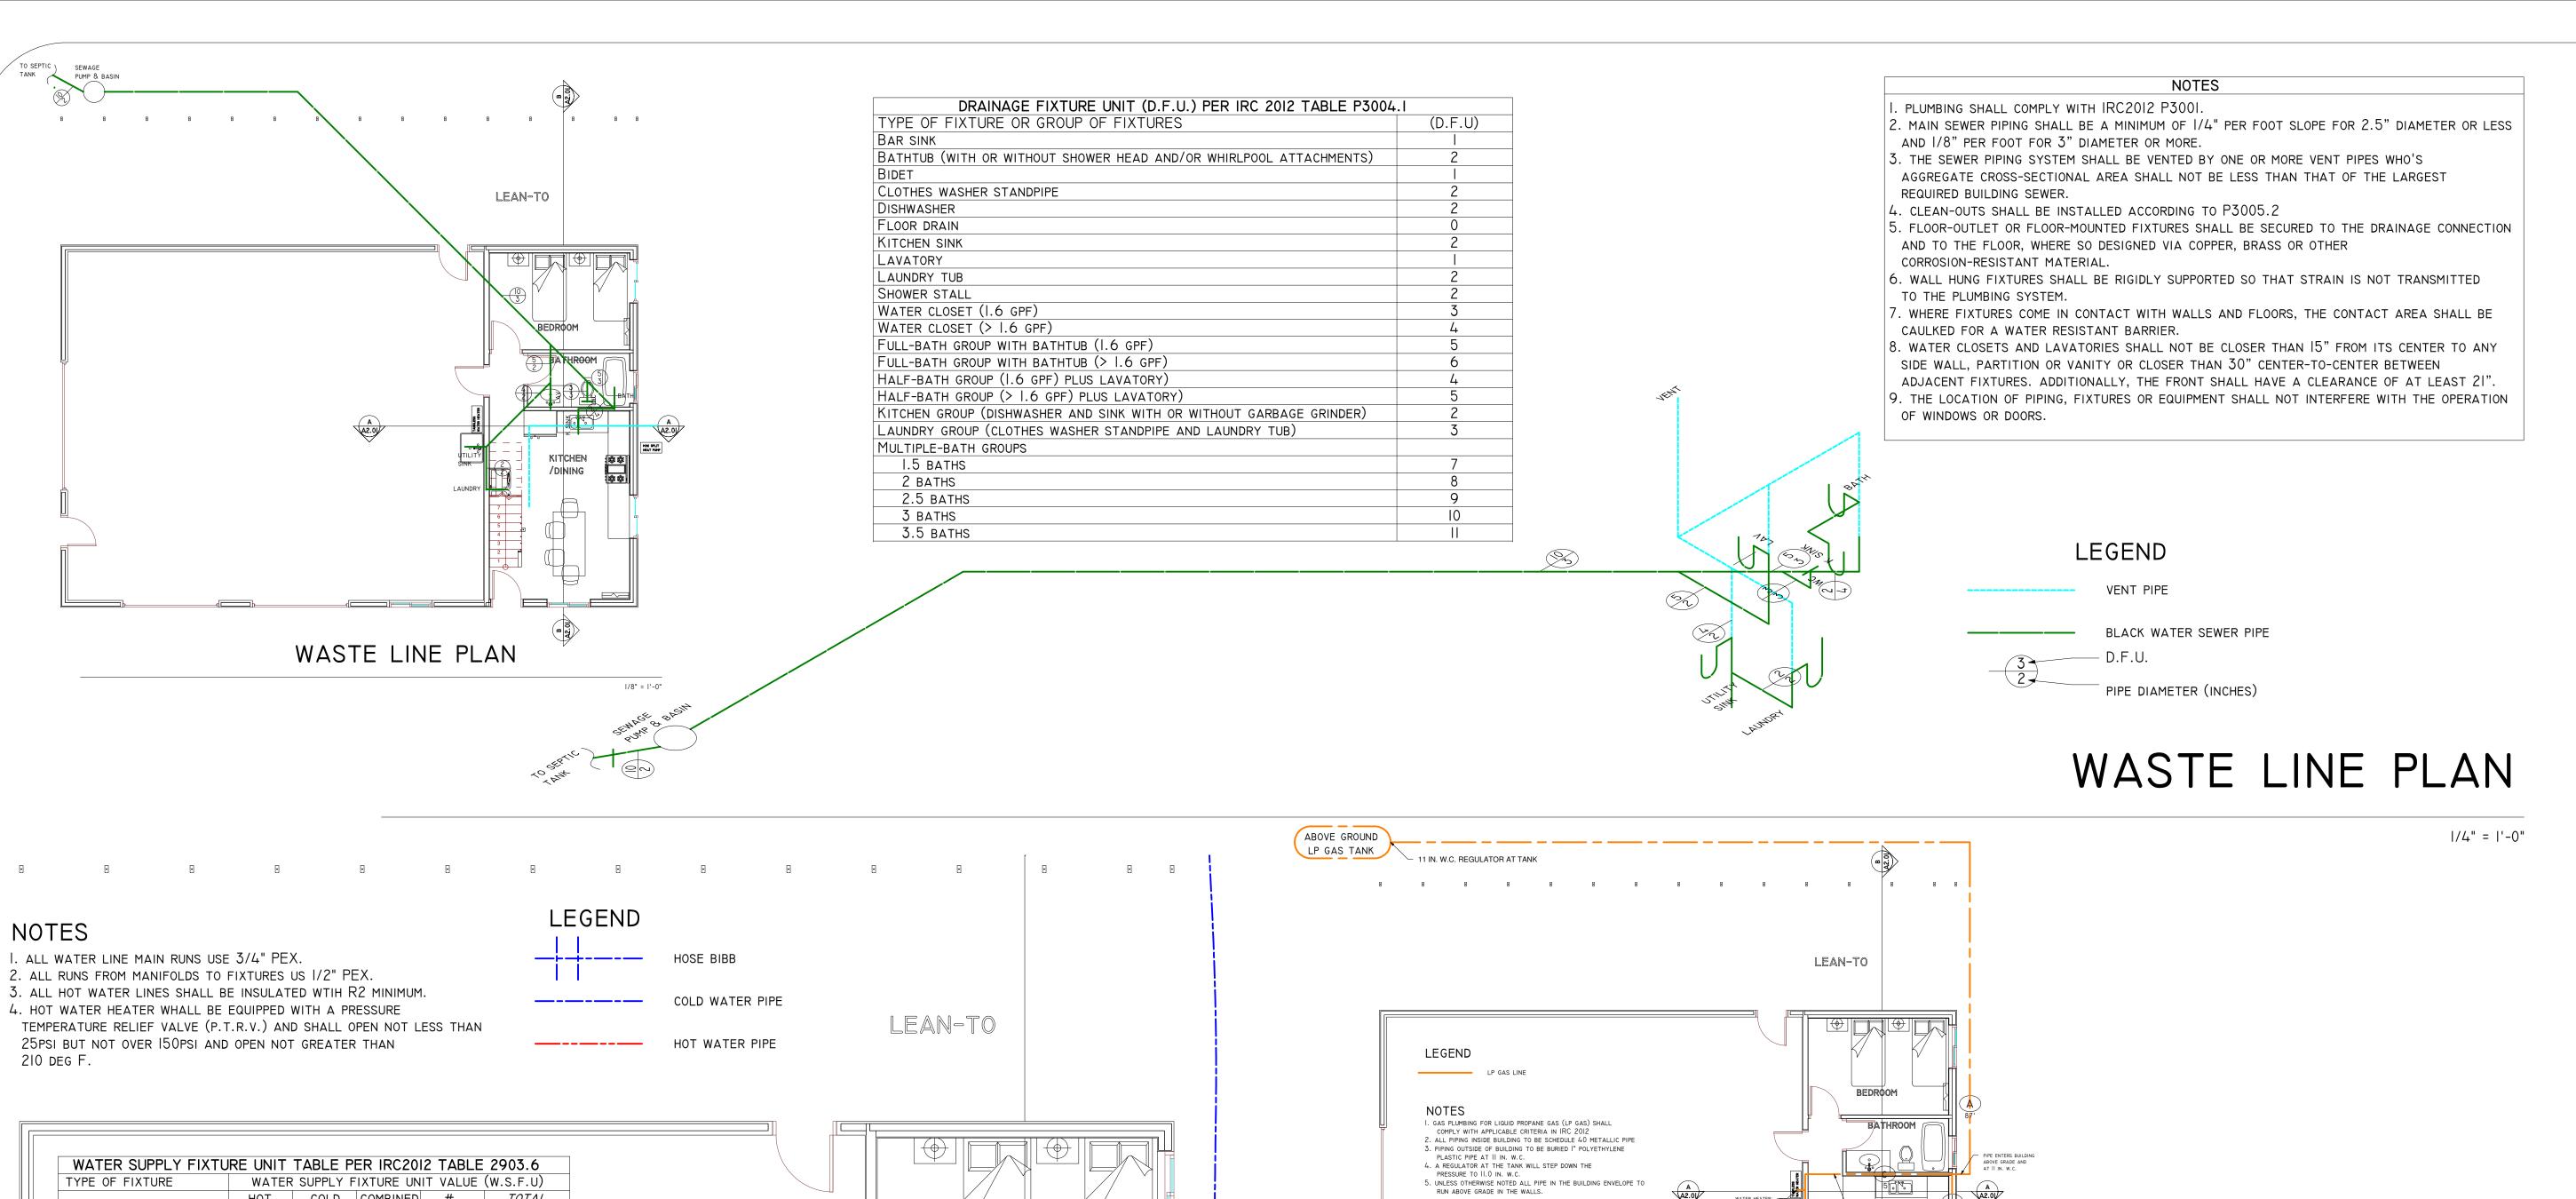___ II IN. W.C. REGULATOR AT TANK

WATER HEATER: 199,900 BTU

DRYER:

35,000 BTU

DENSTEIN RESIDENC ORKSHOP/GIEST HOUS

RD

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0

85

UMB|

General Notes

Added sub panel and misc electrical changes.

REVISION |

INITIAL RELEASE

Revision/Issue

3/15/19

5/18/18

Date

Rev 1: Changes to page E1.01 only.

Drawn By
ADAM GOLDENSTEIN

Date
3/19/2019

Scale
1/4" = 1'-0"

ABOVE GRADE AND AT II IN. W.C.

OVEN/RANGE: 65,000 BTU

RUN IN CEILING

GAS LINE PLAN

BEDROOM

BATHROOM

BATHTUB

DISHWASHER
FULL-BATH GROUP

HOSE BIBB
KITCHEN GROUP

KITCHEN SINK

LAUNDRY TUB

SHOWER STALL

WATER CLOSET

TOTAL (W.S.F.U)

MAX DEV. LENGTH (FT)

PRESSURE (PSI)

LAVATORY

LAUNDRY GROUP

CLOTHES WASHER

HALF-BATH GROUP

0.0

3.6

0.0

2.5

1.4

0.0

0.0

16.4

40

WATERQUICK PRO ADVANCED WQP-A HOT — WATER CIRCULATION PUMP AND SMART CONTROL WITH MANUAL SWITCH (MOVE, OFF AND AUTO):


WATER HEATER SHALL BE MOUNTED A MINIMUM OF 6'-0" ABOVE THE FLOOR.

WATER HEATER TEMPERATURE /PRESSURE RELIEF PIPING RUN ALONG WALL TO EXTERIOR.

WATER HEATER TEMPERATURE
/PRESSURE RELIEF SHALL
TERMINATE OUTSIDE POINTING
DOWN NOT LESS THAN 6" BELOW
AND NOT MORE THAN 24"
ABOVE THE GROUND.

SUPPLY WATER LINE PLAN

G2408.3 (305.5)

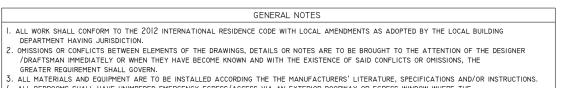

/DRAFTSMAN IMMEDIATELY OR WHEN THEY HAVE BECOME KNOWN AND WITH THE EXISTENCE OF SAID CONFLICTS OR OMISSIONS, THE GREATER REQUIREMENT SHALL GOVERN.

3. ALL MATERIALS AND EQUIPMENT ARE TO BE INSTALLED ACCORDING THE THE MANUFACTURERS' LITERATURE, SPECIFICATIONS AND/OR INSTRUCTIONS.

4. ALL BEDROOMS SHALL HAVE UNIMPEDED EMERGENCY EGRESS/ACCESS VIA AN EXTERIOR DOORWAY OR EGRESS WINDOW WHERE THE MINIMUM OPENING SIZE IS 5.7 FT^2, MINIMUM OPENING HEIGHT IS 24", MINIMUM OPENING WIDTH IS 20", AND MEETING ALL REQUIREMENTS OF IRC SECTION R310.

5. PROVIDE SMOKE DETECTORS ON SEPARATE ELECTRICAL CIRCUITS WITH BATTERY BACKUPS PER IRC SECTION R317

6. ALL HABITABLE AREAS SHALL BE HEATED TO MAINTAIN A MINIMUM OF 68 DEGREES F PER IRC SECTION R303.6

7. PROVIDE TERMITE TREATMENT PER STATE REQUIREMENTS AND IRC SECTION R324. DO NOT DISTURB AFTER APPLICATION AND RETREAT IF CONCRETE IS NOT POURED WITHIN 12 HOURS
8. PROVIDE I HOUR FIRE RESISTIVE WALL CONSTRUCTION CONSISTING OF I LAYER OF 1/2" OR GREATER TYPE 'X' GYPSUM WALL BOARD AT GARAGE WALLS COMMON TO LIVING AREA FROM SOLE PLATE TO GARAGE CEILING LID; PROVIDE 2 LAYERS OF 1/2" OR GREATER TYPE C WHEN TJI'/LPL'S ON 24" O.C. ARE USED.
9. GLASS OR GLAZING IN HAZARDOUS AREAS, DEFINED AS BEING WITHIN 24" OF DOORS OR 18" OFF FLOORS AND OTHER APPLICATIONS IS TO BE TEMPERED OR SAFETY GLASS PER IRC SECTION R508.4

WHEN GYPSUM WALL BOARD IS USED IN TUB/SHOWER AREAS A MOISTURE RATED PRODUCT SHALL BE USED TO A MINIMUM OF 72" ABOVE TUB/SHOWER DRAINS.
 ALL BUILDING JOINTS, SEAMS PENETRATIONS, AND OTHER SOURCES OF AIR LEAKAGE THROUGH THE BUILDING THERMAL ENVELOPE SHALL BE CAULKED, WEATHER STRIPPED, WRAPPED OR OTHERWISE SEALED TO LIMIT UNCONTROLLED AIR MOVEMENT.
 INSULATION SHALL BE PER PLAN. IF INSULATION OF ANY PORTION OF THE THERMAL ENVELOPE IS NOT SHOWN IT SHALL BE INSULATED WITH A MINIMUM AS FOLLOWS: R-19 WALLS, R-10 STEM WALLS, AND R-38 CEILING.

FOUNDATION NOTES

ALL FOOTINGS SHALL REST ON NATURAL UNDISTURBED SOIL, OR ON ENGINEERED CONTROLLED FILL AND SHALL EXTEND A MINIMUM OF 18"
BELOW THE FROST LINE / FINISHED GRADE.
 DESIGN SOIL BEARING: 1500 PSI ASSUMED UNLESS OTHERWISE NOTED. ANY QUESTIONS REGARDING COMPOSITION OR BEARING CAPACITY OF THE SOIL
SHALL BE ADDRESSED BY THE OWNER AND/OR CONTRACTOR. IN THE EVENT OF UNSTABLE CONDITIONS A LICENSED ENGINEER WILL BE CONSULTED.
 ALL VEGETATION AND FOREIGN OBJECTS SHALL BE REMOVED BEFORE PRIOR TO THE PLACEMENT OF FOOTINGS, SLAB OR OTHER
UNDERGROUND INSTALLATIONS.

ALL COMPACTION PROCEDURES IN NATURAL GROUND OR ENGINEERED FILL WHICH THE BEARING WEIGHT OF A STRUCTURE RESTS ON SHALL PROVIDE
FOR A MINIMUM OF 95% DENSITY, WITH VERIFICATION BY A SOILS REPORT FROM A LICENSED SOILS LABORATORY. SLABS FOR PORCHES,
GARAGES, AND DRIVEWAYS SHALL BE COMPACTED BY A PROCESS TO ACHIEVE 95% DENSITY AND VERIFICATION BY A SOILS REPORT IS AT THE
DISCRETION OF THE OWNER.
 ALL CONCRETE WORK SHALL HAVE A MINIMUM COMPREHENSIVE STRENGTH AS OUTLINED IN IRC TABLE R402.2.2 AND ACI318. QUALITY OF ASSURANCE
AND CONTROL OF ALL CONCRETE WORK IS TO CONFORM TO CURRENT ACI SPECIFICATIONS.
 CONCRETE SLABS AND OTHER FLAT WORK SHALL BE GIVEN A MINIMUM 72 HOURS CURING TIME PRIOR TO ANY FORM OF LOADING AND 28 DAYS MINIMUM
OF 28 DAYS BEFORE VEHICULAR TRAFFIC.
 INTERIOR CONCRETE SLABS ARE TO BE TROWELED SMOOTH, EXTERIOR BROOM FINISHED AT EXPOSED AREAS UNLESS OTHERWISE NOTED.

8. ALL CONCRETE MATERIAL SHALL HAVE A MINIMUM CEMENT CONTENT OF 5 SACKS PER YO^3, MINIMUM 2,500 PSI AND CONFORM TO ASTM CI50 TYPE II. AGGREGATE SHALL CONFORM TO ASTM C35. SLUMP TESTING SHALL NOT EXCEED 4" AND WATER MAY NOT BE ADDED AT THE JOB SITE. CONCRETE THAT HAS BEE DELIVERED AND IN TRUCKS, ON THE JOB SITE FOR MORE THAN ½ HOUR WILL NOT BE ACCEPTED.
9. CONCRETE IS TO BE PLACED IN ITS FINAL POSITION AND NOT MOVED OR ALTERED THEREAFTER. APPLY MECHANICAL VIBRATION AT DUCTS OR OTHER STRUCTURES AS NEEDED TO ENSURE COMPLETE PLACEMENT.

FRAMING NOTE

I. FRAMING PLANS INDICATE STRUCTURAL CONDITIONS ONLY AND NOT METHODS OF CONSTRUCTION. INSTALL BLOCKING, BRACING, AND ADDITIONAL MEMBERS AS REQUIRED BY CODE, WHETHER CALLED OUT IN THE DRAWING OR NOT. PROVIDE OR REPLACE NAILERS, BACKING OR OTHER MEMBERS AS NEEDED FOR WALLBOARD, ROOFING, PLUMBING, MECHANICAL AND ELECTRICAL AND OTHER ACCESSORY INSTALLATIONS. REPLACE BENT, BOWED OR DEFECTIVE MEMBERS, LEVEL OR RE-LEVEL WALLS, FOOR AND WINDOW JAMBS PRIOR TO WALLBOARD, AND MEMBERS ALTERED OR DAMAGED BY OTHER TRADES.
2. PLYWOOD SHEATHING SHALL BE CDX (CCX WHEN EXPOSED) OR OSB, THICKNESS PER PLANS AND SHALL BEAR THE STAMP OF AN APPROVED GRADING AGENCY.

3. ALL EXTERIOR WALLS SHALL BE SHEATHED CONTINUOUSLY REGARDLESS OF MINIMUM BRACED WALL REQUIREMENTS.

4. SIL PLATES SHALL BE PRESSURE TREATED AND BE TERMITE, FUNGUS, AND DECAY RESISTANT.

5. ALL FRAMING LUMBER SHALL BE IN SERVICEABLE CONDITION AND CONFORM TO THE LATEST MANUAL EDITION OF WESTERN WOOD PRODUCTS ASSOCIATION OR THE WEST COAST LUMBER INSPECTIONS BUREAU. ALL SAWN LUMBER SHALL BE GRADE STAMPED WITH THE MARK OF AN APPROVED GRADING AGENCY ALL FRAMING LUMBER SHALL BE DOUGLAS FIR LARCH OF THE FOLLOWING GRADES WITH THE MINIMUM PROPERTIES:

JOISTS NO. 2
BEAMS 4" WIDTH: NO. 2
LEDGERS AND TOP PLATES: NO. 2
2X4 AND 2X6 STUDS: NO. 2

POSTS 4X6 AND LARGER: NO. I

6. MANUFACTURED BEAMS ARE TO BE DOUGLAS FIR OR EQUAL AND ARE TO INCLUDE ALL NECESSARY APPURTENANCES AND MATERIAL AND HARDWARE FOR ANCHORAGES, BRIDGING, BRACING, AND SPLICES IN ACCORDANCE WITH MANUFACTURER'S SPECIFICATIONS, WHETHER CALLED OUT ON THE DRAWINGS OR NOT.

7. PROVIDE POSITIVE METAL CONNECTORS PROVIDING FOR ANCHORAGE AND REINFORCEMENT OF ALL STRUCTURAL MEMBERS FROM FOUNDATION THROUGH TO THE TOP OF THE STRUCTURE FOR UPLIFTING AND LATERAL MOVEMENT AS DETAILED IN THE PLANS AND FOR ANY PLACE

DESIGN LOADS: FLOOR: DEAD: 15 PSF, LIVE LOAD 40 PSF GENERAL FASTENER NOTES

1. ALL NAILS ARE SMOOTH-COMMON, BOX OR DEFORMED SHANKS EXCEPT WHERE OTHERWISE STATED, NAILS USED FOR FRAMING AND SHEATHING CONNECTIONS SHALL HAVE A MINIMUM AVERAGE BENDING YIELD STEENGTHS AS SHOWN. BOLIST FOR SHANK DIAMETERS OF 0.162 INCH (200 COMMON NAIL), 90KSI FOR SHANK DIAMETERS OF 0.162 INCH (200 COMMON NAIL), 90KSI FOR SHANK DIAMETERS OF 0.162 INCH OR LESS.

2. NAILS SHALL BE SACED AT NOT MORE THAN 6 INCHES ON CENTER AT ALL SUPPORTS WHERE SPANS ARE 4.8 INCHES OR GREATER.

3. NAILS ATTACHING WOOD STRUCTURAL EPANEL ROOF SHEATHING TO INTERMEDIATE SUPPORTS SHALL BE SPACED 6 INCHES ON CENTER FOR A MINIMUM 48-INCH DISTANCE FROM RIDGES, EAVES, AND GABLE BUT WALLS, AND 4 INCHES ON CENTER FOR ABLE END WALL FRAMING.

4. UNLESS OTHERWISE NOTED ATTACHMENTS VIA BRACKETS, HANGERS, ETC SHALL FOLLOW THE MANUFACTURERS FASTENER SCHEDULE FOR THE MINIMUM DESIGN LOAD OR BETTER.

5. IN CASE OF A CONTRADICTION OF THE GENERAL FASTENER SCHEDULE AND FASTENER REQUIRED BY A DETAIL DRAWING OR CALL OUT, THE CALL OUT OR DETAIL DRAWING SHALL TAKE PRECEDENCE WILLESS IT RESULTS IN A INVERSION CONNECTION.

FASTENER SCHEDULE: GENERAL STRUCTURAL MEMBER INE CONNECTION

JOIST TO SILL OR GIRDER BRIDGING TO JOIST TOENAIL EACH END IAD AT IA" O.C. TYPICAL FACE NAIL SOLE PLATE TO JOIST OR BLOCKING SOLE PLATE TO JOIST OR BLOCKING AT BRACED WALL PANEL 3-16D AT 16" O.C. BRACED WALL PANEL TOP PLATE TO STUD 2-16D END NAIL 4-8D / 2-16D TOENAIL / END NAIL STUD TO SOLE PLATE DOUBLE STUDS 16D AT 24" O.C. FACE NAIL DOUBLE TOP PLATES
DOUBLE TOP PLATES 24" OFFSET OF END JOINTS 16D AT 16" O.C. TYPICAL FACE NAIL
8-16D FACE NAIL IN LAPPED AREA O BLOCKING BETWEEN JOISTS OR RAFTERS TO TOP PLATE RIM JOIST TO TOP PLATE

TOP PLATE, LAPS, CORNERS AND INTERSECTIONS 8D AT 6" O.C. FACE NAIL CONTINUOUS HEADER, TWO PIECES
CONTINUOUS HEADER TO STUD 16" O.C. ALONG EDGE RAFTER TO PLATE 6 BUILT-UP CORNER STUDS 20D 32" O.C. FACE NAIL 32" O.C. STAGGERED 7 BUILT-UP GIRDER AND BEAMS & FACE NAIL AT ENDS AND SPLICES

JACK STUD SCHEDULE

OPENING WIDTH STUDS REQUIRED


0'-0" TO 4'-0" (2)-2x4


4'-1" TO 5'-6" (2)2x4


5'-7" TO 6'-5" (2)-2x4

6'6" TO 18'-0" SEE FLOOR PLAN

OPENING WIDTH HEADER SIZE

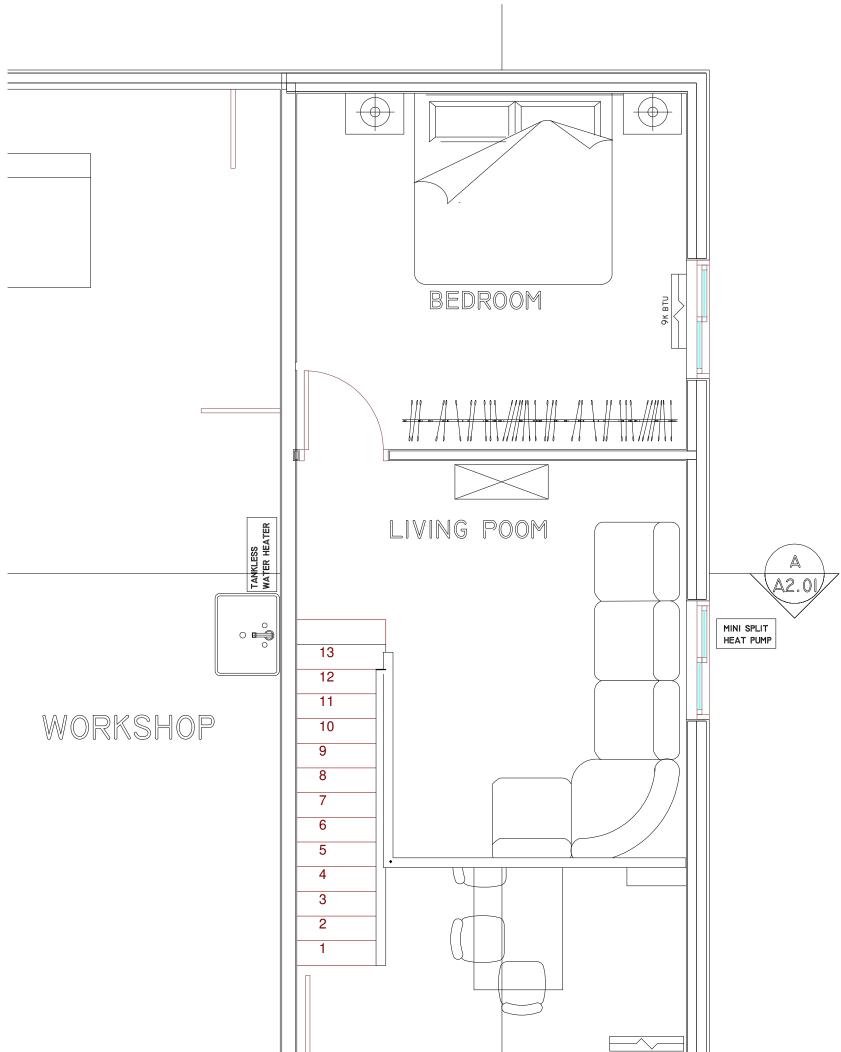

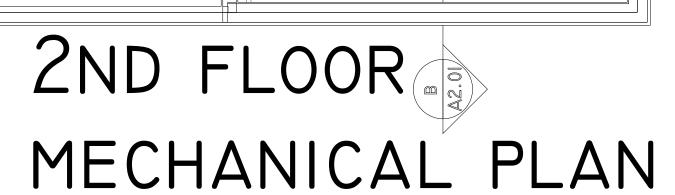


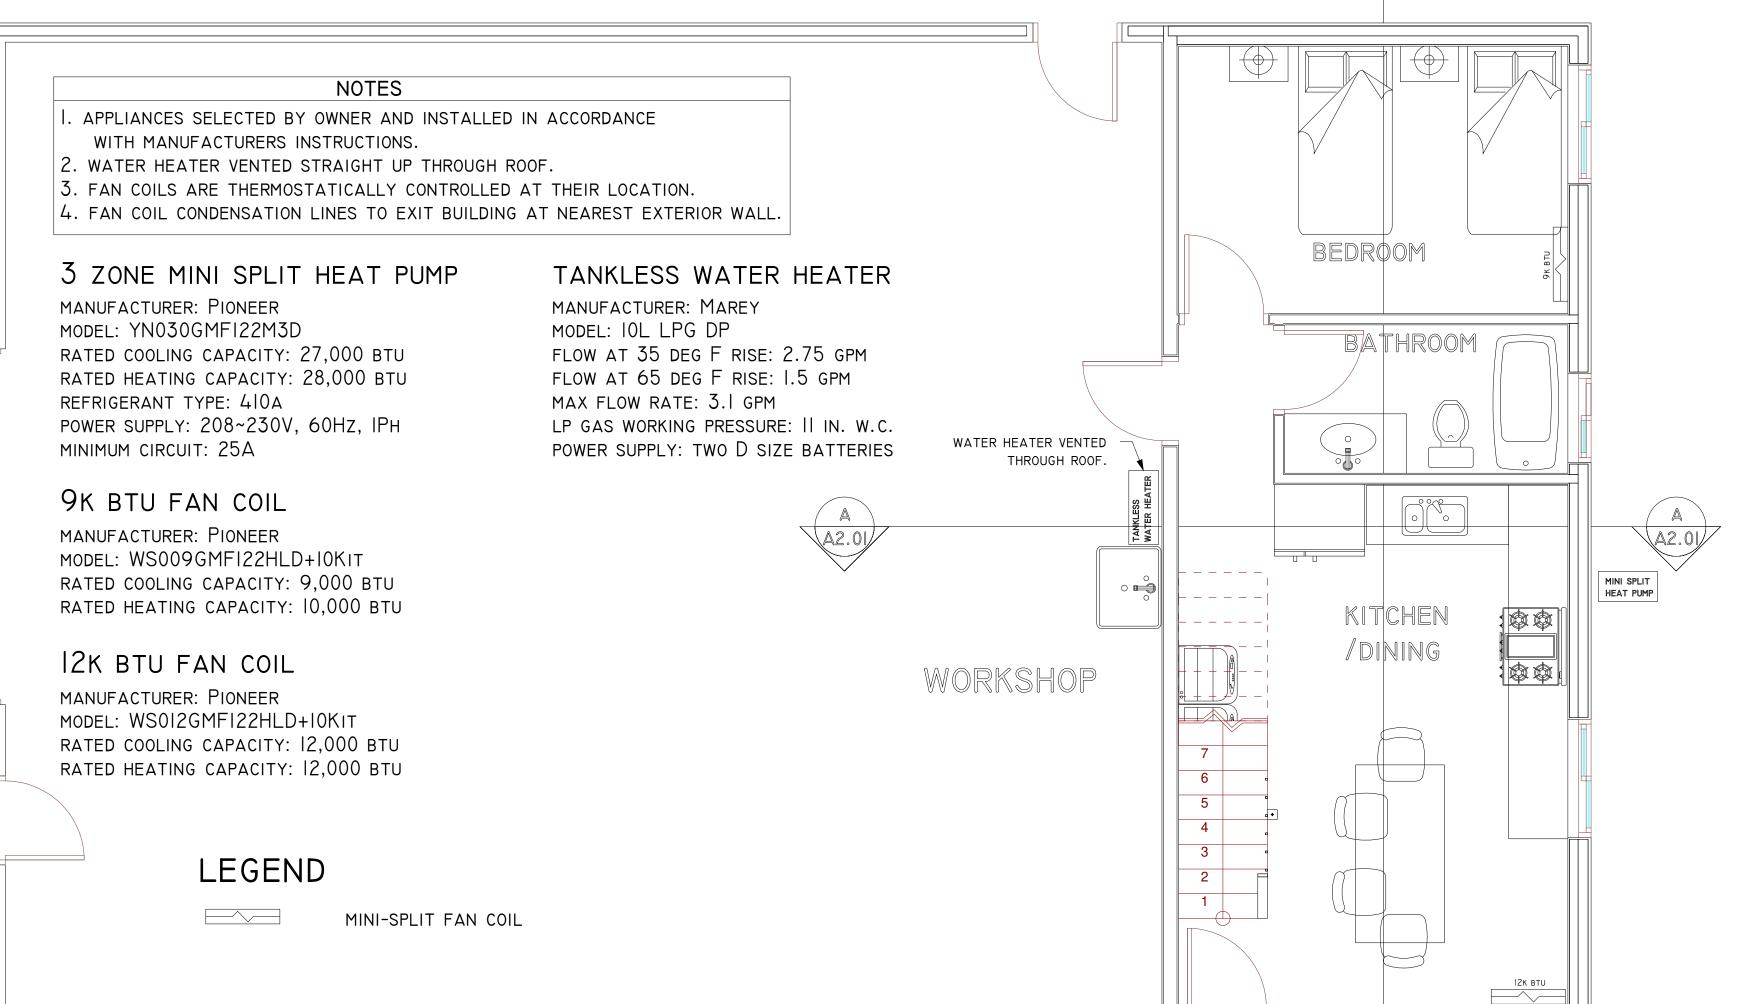

IST FLOOR MECHANICAL PLAN

LEAN-TO

|/4" = |'-0"

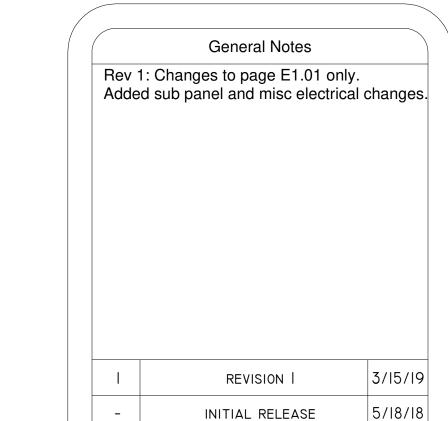

Revision/Issue

Date


MECHANICAL PLANS R GENERAL NOTES

GOLDENSTEIN RESIDENCE
WORKSHOP/GUEST HOUSE
10685 E ROCKY HILL RD
DEWEY, AZ 86327

Drawn By
ADAM GOLDENSTEIN

Date
3/19/2019

Scale
1/4" = 1'-0"

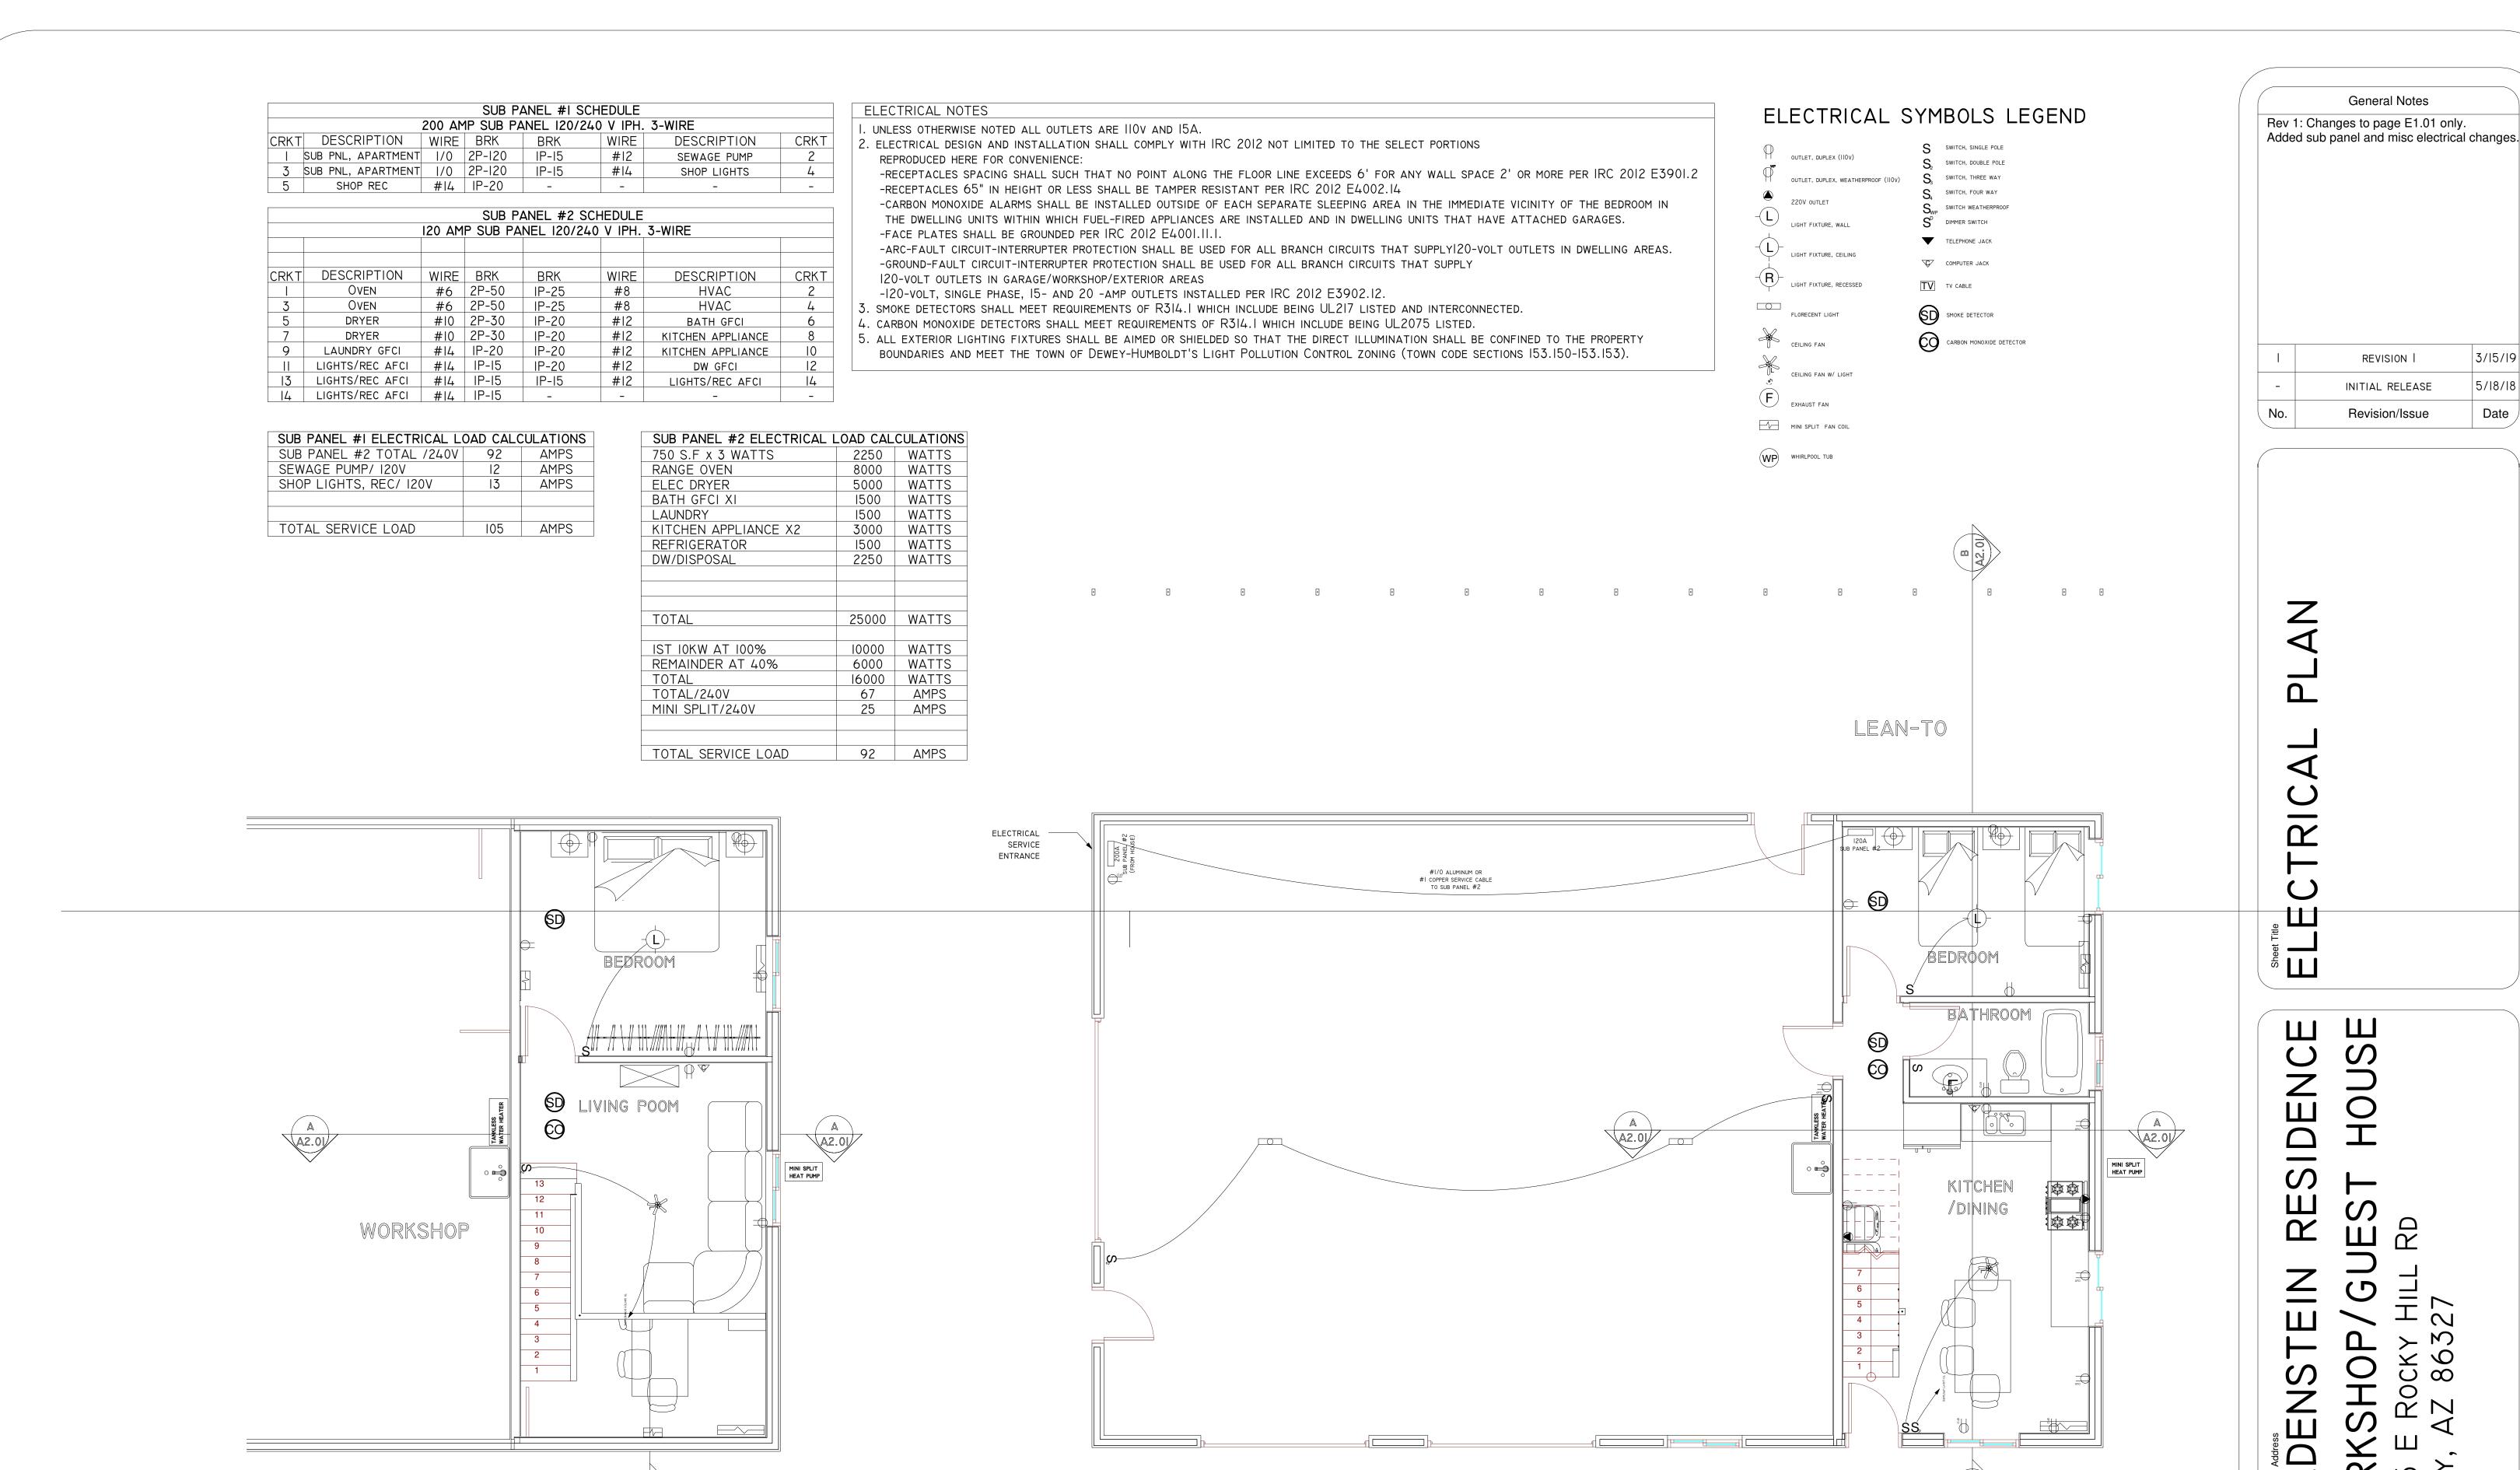

2ND FLOOR

ELECTRICAL PLAN

1/4" = 1'-0"

|/4" = |'-0"

IST FLOOR ELECTRICAL PLAN

Drawn By
ADAM GOLDENSTEIN E1.01 3/19/2019 |/4" = |'-0"

10685 Dewey

3/15/19

5/18/18

Date